

# Staff Report

PLANNING DIVISION
COMMUNITY & ECONOMIC DEVELOPMENT

To: Salt Lake City Planning Commission

From: Katia Pace, (801) 535-6354

Date: November 12, 2014

Re: PLNPCM2014-00178 AT&T Rooftop Antennae at 115 South 1100 East (Arlington Place)

#### **CONDITIONAL USE**

**PROPERTY ADDRESS:** 115 South 1100 East (Arlington Place)

**PARCEL ID:** 16-05-208-001

**MASTER PLAN:** Central Community

**ZONING DISTRICT:** RMF-45 (Moderate/High Density Multifamily Residential)

**REQUEST:** The petitioner, Rachel Fenton, representing AT&T, is requesting a conditional use approval for new unmanned wireless antennae located on the rooftop of the Arlington Place located at 115 South 1100 East. The equipment cabinets are proposed to be installed in an existing storage room in the parking garage. This project is located in the RMF-45 (Moderate/High Density Multifamily Residential) zoning district. As per Section 21A.40.090(E) of the Zoning Ordinance all rooftop mounted antennae in the RMF-45 zone require conditional use approval.

Zoning Ordinance section 21A.54.155 authorizes administrative approval of this type of conditional use; however, because of some neighborhood opposition this request is being forwarded to the Planning Commission. This site is within the University Historic District and as such it will require review for its appropriateness in a historic district.

**RECOMMENDATION:** Planning Staff recommends that the Planning Commission approve the proposed conditional use. The motion to approve is below:

Based on the information in this staff report, public testimony, and discussion by the Planning Commission, I move that the Planning Commission approve application PLNPCM2014-00178, for AT&T Rooftop Antenna at 115 South 1100 East with the following conditions:

- 1. Any modifications to the approved plans after the issuance of a building permit must be specifically requested and approved by the Planning Division prior to execution.
- 2. The request will require a Certificate of Appropriateness for historic appropriateness approval.
- 3. Conditional Use approval expires within one year of the date of approval unless all required permits are obtained.
- 4. Applicant shall comply with all other department/division requirements.

#### **ATTACHMENTS:**

- A. Vicinity Map
- **B.** Photos
- C. Site Plan & Elevations
- **D.** Existing Conditions & Zoning Requirements
- **E.** Analysis of Standards
- F. Public Process and Comments
- **G.** Dept. Comments
- H. Motions

#### PROJECT DESCRIPTION:

The request is for new unmanned wireless antennae located on the rooftop of the Arlington Place located at 115 South 1100 East. If approved, the proposal would provide service to AT&T customers in the surrounding area.

This is a U-shaped multi-family building, eight stories high. The site is situated within the University Historic District, however, the building is considered noncontributing to the historic district. Currently T-Mobile has six existing antennae that are wall-mounted in three different locations and with two antennae on each location around the roof. According to the applicant, T-Mobile does not agree to collocate.

Originally the applicant requested approval for stealth antennae; the proposal was to build structures that would represent chimneys to conceal the antennae. The structure would be approximately 10 feet wide by 10 feet high. Through an Administrative Interpretation the Planning Division determined that the structures could not represent chimneys due to the size being too big and not complying with the zoning regulations.

The applicant has modified the request and is asking for rooftop antennae without enclosures. The updated request is for three antennae boxes located on three different locations on the rooftop of the building. Each of the squid boxes will hold four antennae, the antennae will be aligned on angles but will be further than ten feet from the parapet wall of the building, and the antennae will be eight to six feet high. All conduit and fiber cables are proposed to run down through an existing stairwell and will connect to the equipment cabinets that are proposed to be installed in an existing storage room in the parking garage.

#### **KEY ISSUES:**

The subject building is approximately 66 feet high and it exceeds the maximum building height in the RMF-45 zoning district by 21 feet. However, Zoning Ordinance section 21A.40.090.E.8 allows roof antennae on buildings that exceed the maximum allowable height of the zoning district if said antenna is allowed on the zoning district. Roof top antennae are listed as a conditional use in the RMF-45 zoning district and therefore, if approved according to the standards, are allowed.

The subject property is located in a historic district and if approved as a conditional use it will also require a Certificate of Appropriateness for historical approval. As a guideline, the equipment should, to the greatest extent possible, be situated where it will not have a visual impact upon the site, the building or its roof profile.

Some neighbors are concerned that the proposed antennae will be located across the street from an electrical substation and that the addition of the antennae will detract from the residential integrity of the neighborhood and create an industrial feel to the area and consequently reduce property values. However, no evidence has been submitted to suggest that this concern is valid and the impact on property values is not one of the listed standards for conditional use approval. Furthermore, the intent of moving the antennae away from the edge of the building is to reduce their visual impact, which is aimed at mitigating the visual impact.

#### Over-the-Air Reception Devices ("OTARD") Rule

As directed by Congress in Section 207 of the Telecommunications Act of 1996, and amended in 2000, the Federal Communications Commission adopted the Over-the-Air Reception Devices ("OTARD") rule concerning governmental and nongovernmental restrictions on wireless antennae and other devices.

The rule applies to state or local laws or regulations, including zoning, land-use or building regulations. A restriction impairs if it: (1) unreasonably delays or prevents use of; (2) unreasonably increases the cost of; or (3) precludes a person from receiving or transmitting an acceptable quality signal from an antenna covered under the rule. The rule does not prohibit legitimate safety restrictions or restrictions designed to preserve designated or eligible historic or prehistoric properties, provided the restriction is no more burdensome than necessary to accomplish the safety or preservation purpose.

The request meets all zoning requirements for a conditional use. As discussed, the proposal is also subject to historic review because the site is located in a locally designated historic district. That review, which is not within the authority of the Planning Commission, is required by ordinance and will be done if the Planning Commission approves the request. This is also listed a conditional of approval in the recommendation of the Planning Staff.

**NEXT STEPS:** If approved, the applicant will be required to obtain all necessary building permits for the project.

### **ATTACHMENT A: VICINITY MAP**





**LOOKING EAST** 



LOOKING NORTHEAST

### **ATTACHMENT C: SITE PLAN & ELEVATIONS**



# VIRGINIA SLKCUTU1050 FA# 10547729

115 SOUTH 1100 EAST SALT LAKE CITY, UT 84102



### CODE COMPLIANCE

ALL WORK AND MATERIALS SHALL BE PERFORMED AND INSTALLED IN ACCORDANCE WITH THE CURRENT EDITIONS OF THE FOLLOWING CODES AS ADOPTED BY THE LOCAL GOVERNING AUTHORITIES. NOTHING IN THESE PLANS IS TO BE CONSTRUCTED TO PERMIT WORK NOT CONFORMING TO THESE CODES.

- 1. 2012 INTERNATIONAL BUILDING CODE (IBC)
- 2. 2011 NATIONAL ELECTRIC CODE (NEC)
- 3. 2012 INTERNATIONAL MECHANICAL CODE (IMC)
- 4. INTERNATIONAL FIRE CODE
- 5. 2009 INTERNATIONAL ENERGY CONSERVATION CODE (IECC)
- 6. ANY LOCAL BUILDING CODE AMENDMENTS TO THE ABOVE

Project Description: AT&T is proposing a new unmanned wireless telecommunications facility located on the rooftop of the Arlington Place Apartments. Design consists of both panel antenna and equipment to be located on (3) separate frames. All equipment is proposed to be installed in an existing storage room in the parking garage.

PROJECT DESCRIPTION

### DRIVING DIRECTIONS

Directions beginning from AT&T office at: 4393 S. Riverboat Road, Taylorsville, UT 84123 Driving directions to 115 S 1100 E.:

- 1. Head south on Riverboat Rd toward W 4500 S.
- 2. Take the 1st left onto W 4500 S 0.7 mi
- 3. Turn left to merge onto I-15 N 3.3 mi 4. Merge onto I-15 N/I-80 W 2.3mi
- 5. Take exit 306 to merge onto W 600 S 1.4 mi
- 6. Turn left onto S State Street 0.9 mi
- 7. Turn right onto E South Temple Street 1.5 mi

### 8. Turn right onto S 1100 E. 0.2 mi

### GENERAL CONTRACTOR NOTES

DO NOT SCALE DRAWING:

CONTRACTOR SHALL VERIFY ALL PLANS AND EXISTING DIMENSIONS AND CONDITIONS ON THE JOB SITE AND SHALL IMMEDIATELY NOTIFY THE ARCHITECT IN WRITING OF ANY DISCREPANCIES BEFORE PROCEEDING WITH THE WORK OR BE RESPONSIBLE FOR SAME.


THESE ARE ZONING DRAWINGS AND ARE NOT TO BE USED FOR CONSTRUCTION

SHEET INDEX

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SHEET	DESCRIPTION		SAN	
T1	TITLE SHEET, SITE INFORMATION AND VICINITY MAP			
C1	SITE PLAN		— DRAWN BY —	
C1.1	PROPOSED EQUIPMENT LAYOUT AND ANTENNA PLAN			
C2	ELEVATION		AN	

### **VICINITY MAP**

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APPROVALS
LANDLORD:
CONSTRUCTION MANAGER:
RF ENGINEER:
SITE ACQUISITION MANAGER:
ZONING MANAGER:
UTILITY COORDINATOR:
PROGRAM REGIONAL MANAGER:
NETWORK OPERATIONS MANAGER:

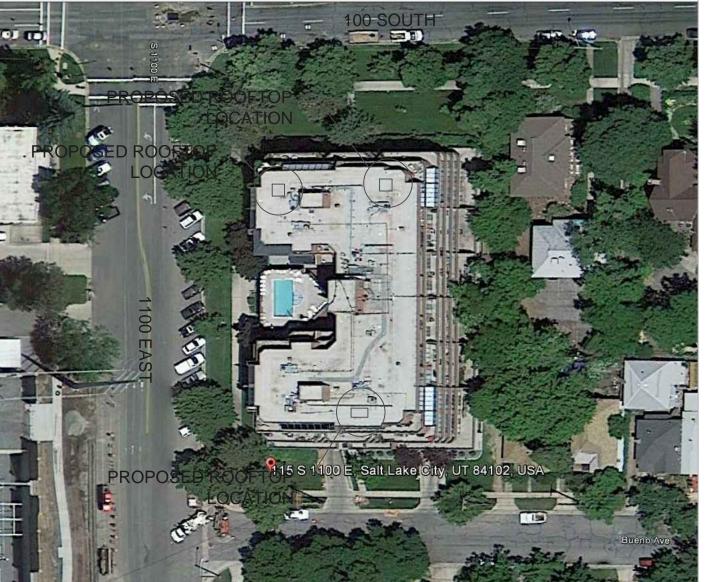

PROJECT INFORMATION

VIRGINIA SITE ID: SLKCUTUIØ5Ø FA# 10547729

CURRENT ISSUE DATE

03/18/2014

ISSUED FOR

ZONING DRAWINGS

REY	— DATE —	DESCRIPTION	– BY –
1	Ø3/18/2Ø14	90% ZONING DRAWINGS	AN
2	Ø4/Ø3/2Ø14	100% ZONING DRAWINGS	AN
3	06/18/2014	REVISION SET BACK IØFT PER CITY COMMENT	AN
4	Ø9/25/2Ø14	REVISION SET BACK IØFT PER CITY COMMENT	AN
5	10/06/2014	REVISION REMOVE STEALTH WALL	AN

PLANS PREPARED BY



1155 EAST WILMINGTON AVENUE SUITE 250 SALT LAKE CITY, UTAH 84106 (801) 487-3330


CONSULTANT

### NSA WIRELESS, INC

2010 CROW CANYON PLACE SUITE 335 RAMON, CA 94583

ı			
	- DRAWN BY -	CHK	APV
	AN		

- LICENSER

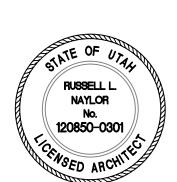

THESE ARE ZONING DRAWINGS AND ARE NOT TO BE USED FOR CONSTRUCTION

SHEET TITLE

TITLE SHEET

SHEET NUMBER

### PROJECT TEAM

BYRON BOSSHARDT AT&T UID: BB572m 4393 RIVERBOAT RD, SUITE 400 TAYLORSVILLE, UT 84123 PHONE: (801) 458-8888

APPLICANT/ LESSEE

### SIMI AJOSE

RF ENGINEER:

AT&T 4393 S. RIVERBOAT ROAD TAYLORSVILLE, UT 84123 PHONE: (214) 695-6965 EMAIL: sa111v@att.com

### SITE ACQUISITION:

EMAIL:bb572m@att.com

RACHEL FENTON NSA WIRELESS, INC. 2010 CROW CANYON PLACE SUITE 335 SAN RAMON, CA 94583 PHONE: (925) 244-1890 EMAIL: rachel.fenton@nsawireless.com

### ARCHITECT/ ENGINEER:

ADAM NAYLOR NICHOLS NAYLOR ARCHITECTS 1155 E WILMINGTON AVE. SALT LAKE CITY, UT 84106 PHONE: (801) 487-3330

### **ZONING MANAGER:**

RACHEL FENTON NSA WIRELESS, INC. 2010 CROW CANYON PLACE SUITE 335 SAN RAMON, CA 94583 PHONE: (925) 244-1890 EMAIL: rachel.fenton@nsawireless.com

### AT&T CONSTRUCTION:

JAVIER ZAMORA ROCKY MT REGION NSB CONSTRUCTION MANAGER UTAH-IDAHO-MONTANA- N. WYOMING 4393 RIVERBOAT RD EMAIL: adamn@nicholsnaylor.com TAYLORSVILLE, UTAH 84123-2503 CELL: (801) 682-7461 EMAIL: jz6220@att.com

### PROJECT INFORMATION

SITE ADDRESS 115 SOUTH 1100 EAST SALT LAKE CITY, UT 84102 APN 16-05-208-001 LAND/ PROPERTY OWNER: ARLINGTON PLACE CONDOMINIUMS CONTACT: DEVIN - BUILDING MANAGER PHONE: (801) 538-0389

PENTHOUSE COORDINATES LATITUDE: LONGITUDE:

**GROUND ELEVATION: HEIGHT OF BUILDING:** HEIGHT OF NEW STRUCTURE: TOP OF ANTENNA:

AMSL 4573 (MAIN ROOF) APPROX. 97'-10.5" 10 FT 4583 FT

RMF-45

N/A

40.7666474

-111.859119

**ZONING:** JURISDICTION: TYPE OF CONSTRUCTION: OCCUPANCY:

**BUILDING USE:** UTILITIES

TELEPHONE:

POWER:


**CENTURY LINK** 

SALT LAKE CITY

UNOCCUPIED


**ROCKY MOUNTAIN POWER** 

EMAIL: arlingtonplace@horizonhoa.com

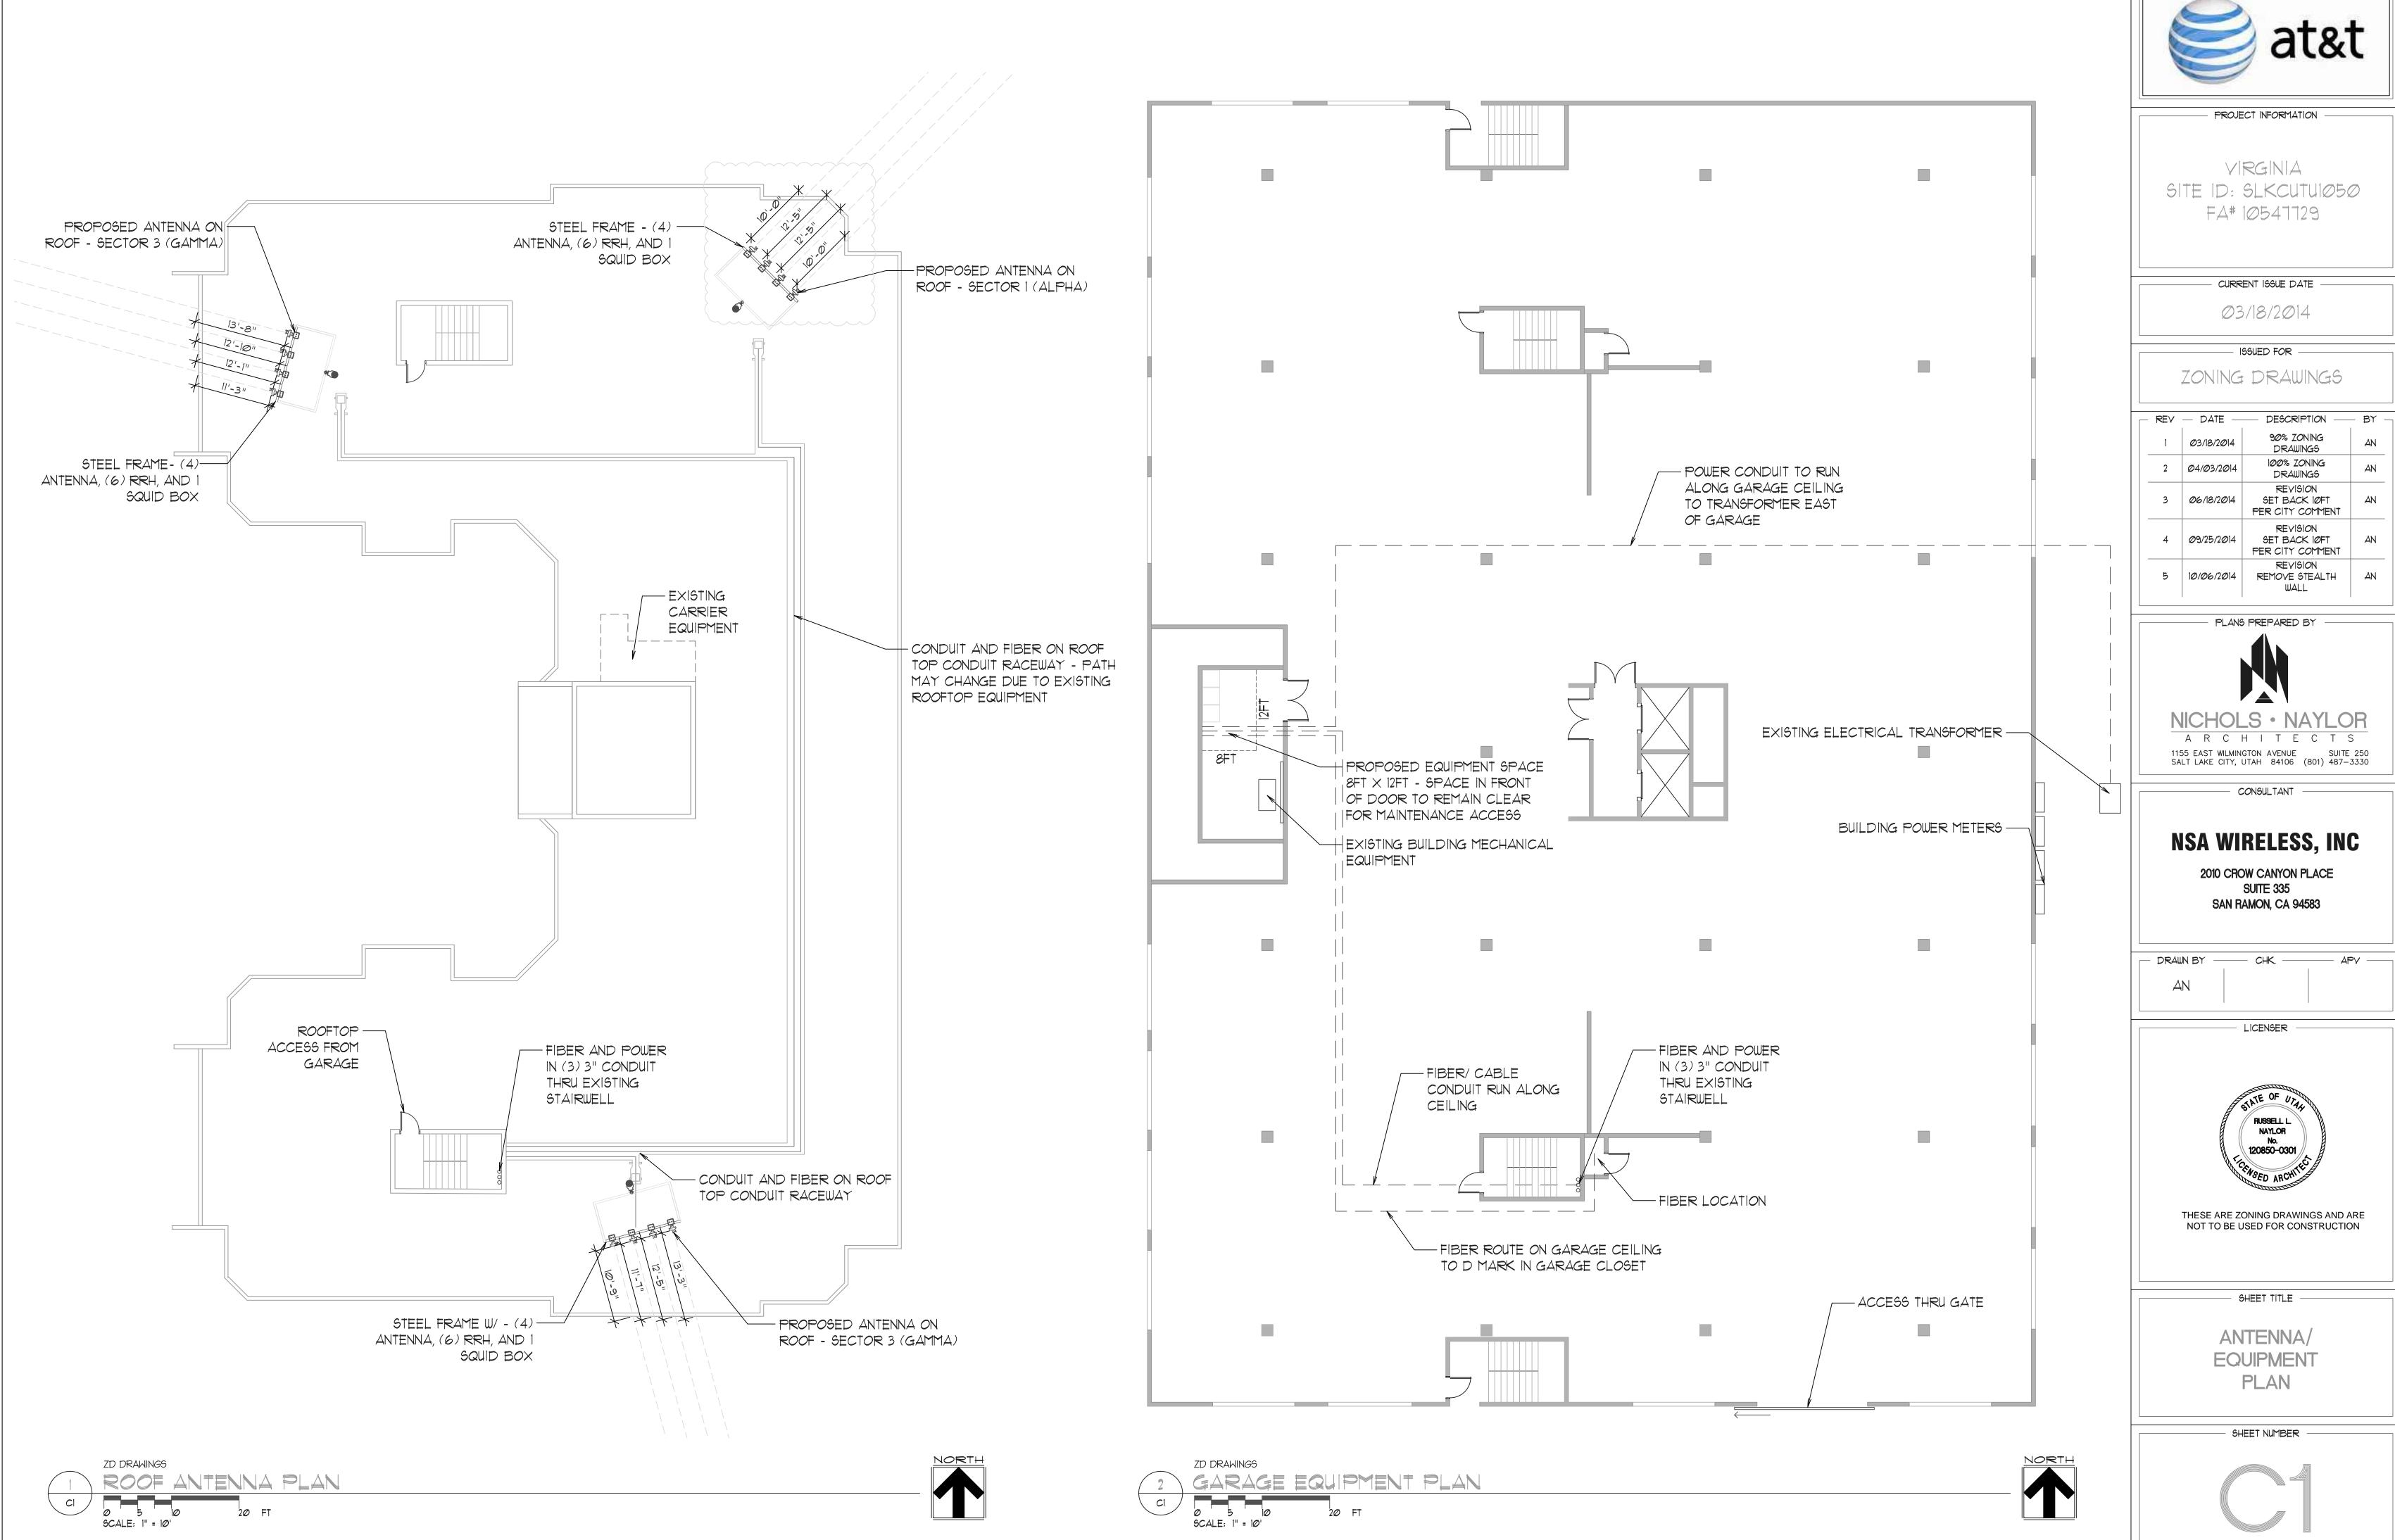





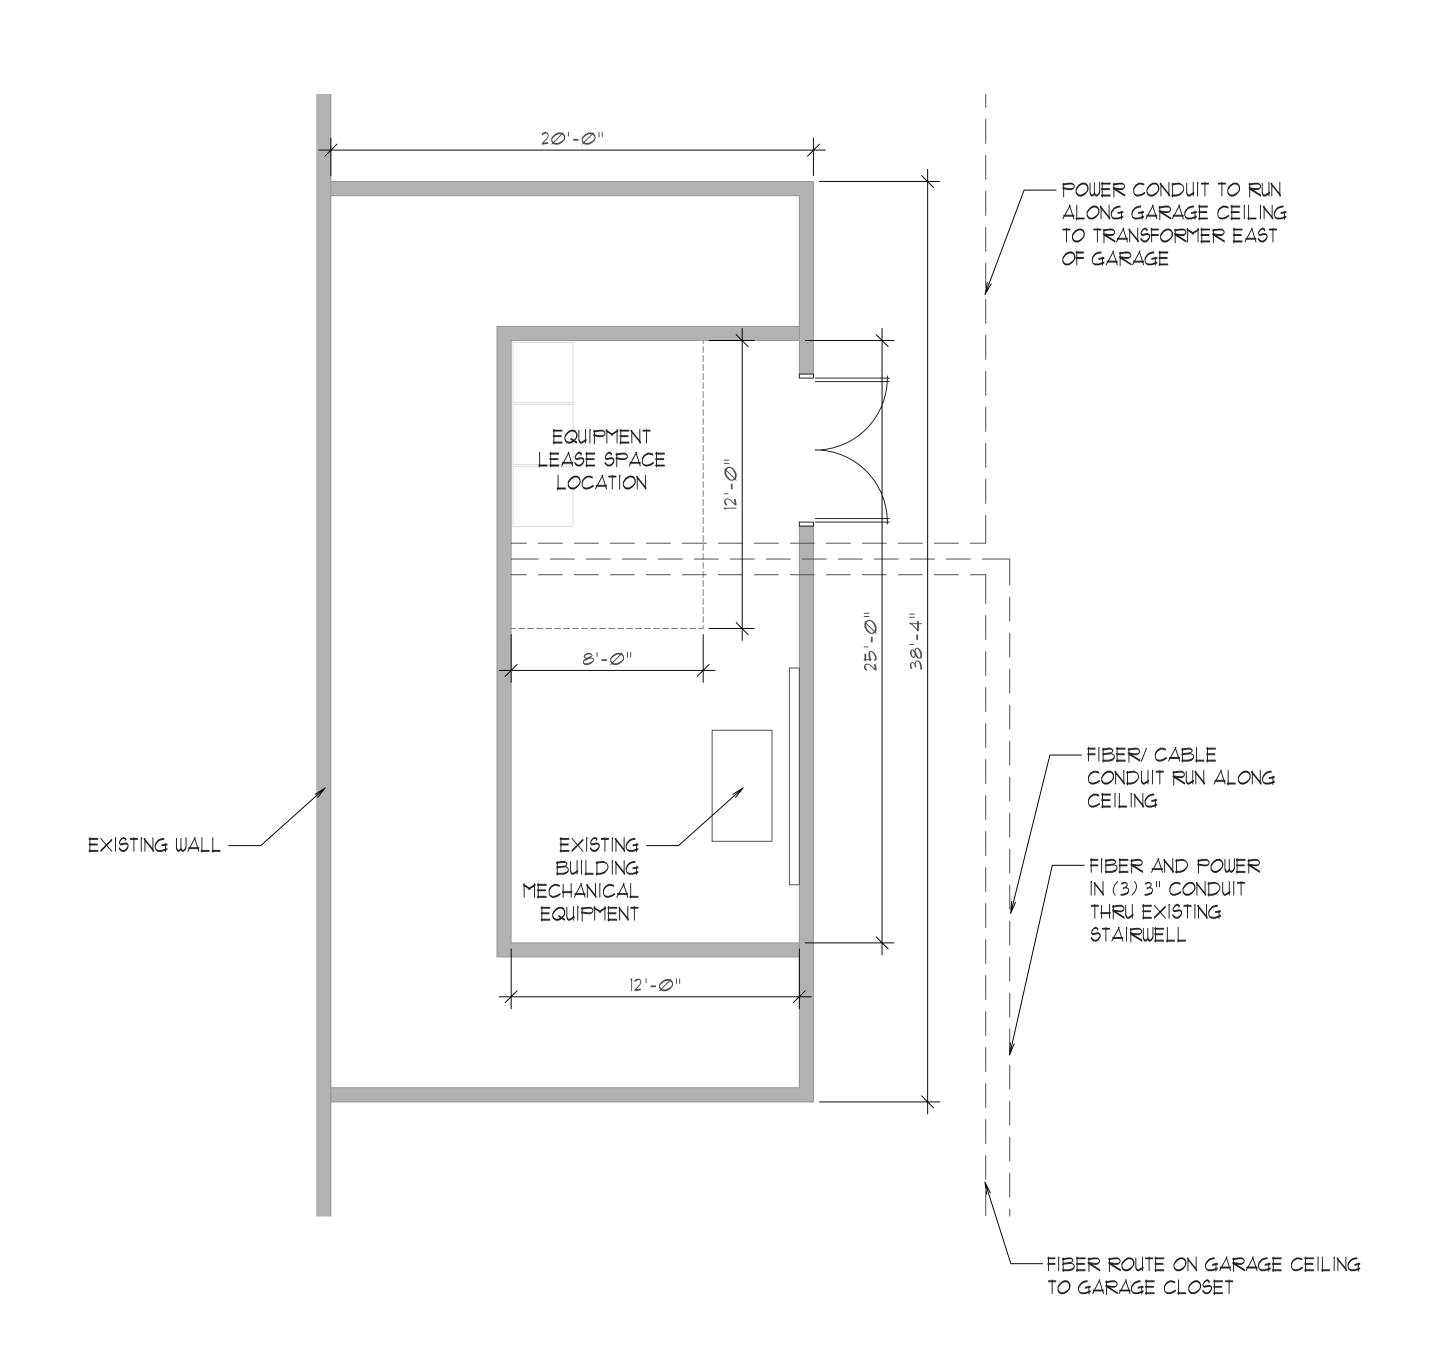

EQUIPMENT LOCATION

Ø | 2 3 4 SCALE: 1/4" = 1'-0"





PROJECT INFORMATION —

VIRGINIA SITE ID: SLKCUTUIØ5Ø FA# 1Ø547729

- CURRENT ISSUE DATE -

03/18/2014

- ISSUED FOR -

ZONING DRAWINGS

- REY	— DATE —	DESCRIPTION	_ BY _
1	Ø3/18/2 <b>Ø</b> 14	90% ZONING DRAWINGS	AN
2	Ø4/Ø3/2Ø14	100% ZONING DRAWINGS	AN
3	06/18/2014	REVISION SET BACK IØFT PER CITY COMMENT	AN
4	<i>0</i> 9/25/2 <i>0</i> 14	REVISION SET BACK IØFT PER CITY COMMENT	AN
5	10/06/2014	REVISION REMOVE STEALTH WALL	AN

- PLANS PREPARED BY -



A R C H I T E C T S

1155 EAST WILMINGTON AVENUE SUITE 250
SALT LAKE CITY, UTAH 84106 (801) 487-3330


CONSULTANT -

## **NSA WIRELESS, INC**

2010 CROW CANYON PLACE SUITE 335 SAN RAMON, CA 94583

- DRAWN BY	CHK	APV
AN		

- LICENSER

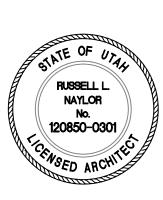


THESE ARE ZONING DRAWINGS AND ARE NOT TO BE USED FOR CONSTRUCTION

- SHEET TITLE -

ENLARGED PLANS

---- SHEET NUMBER

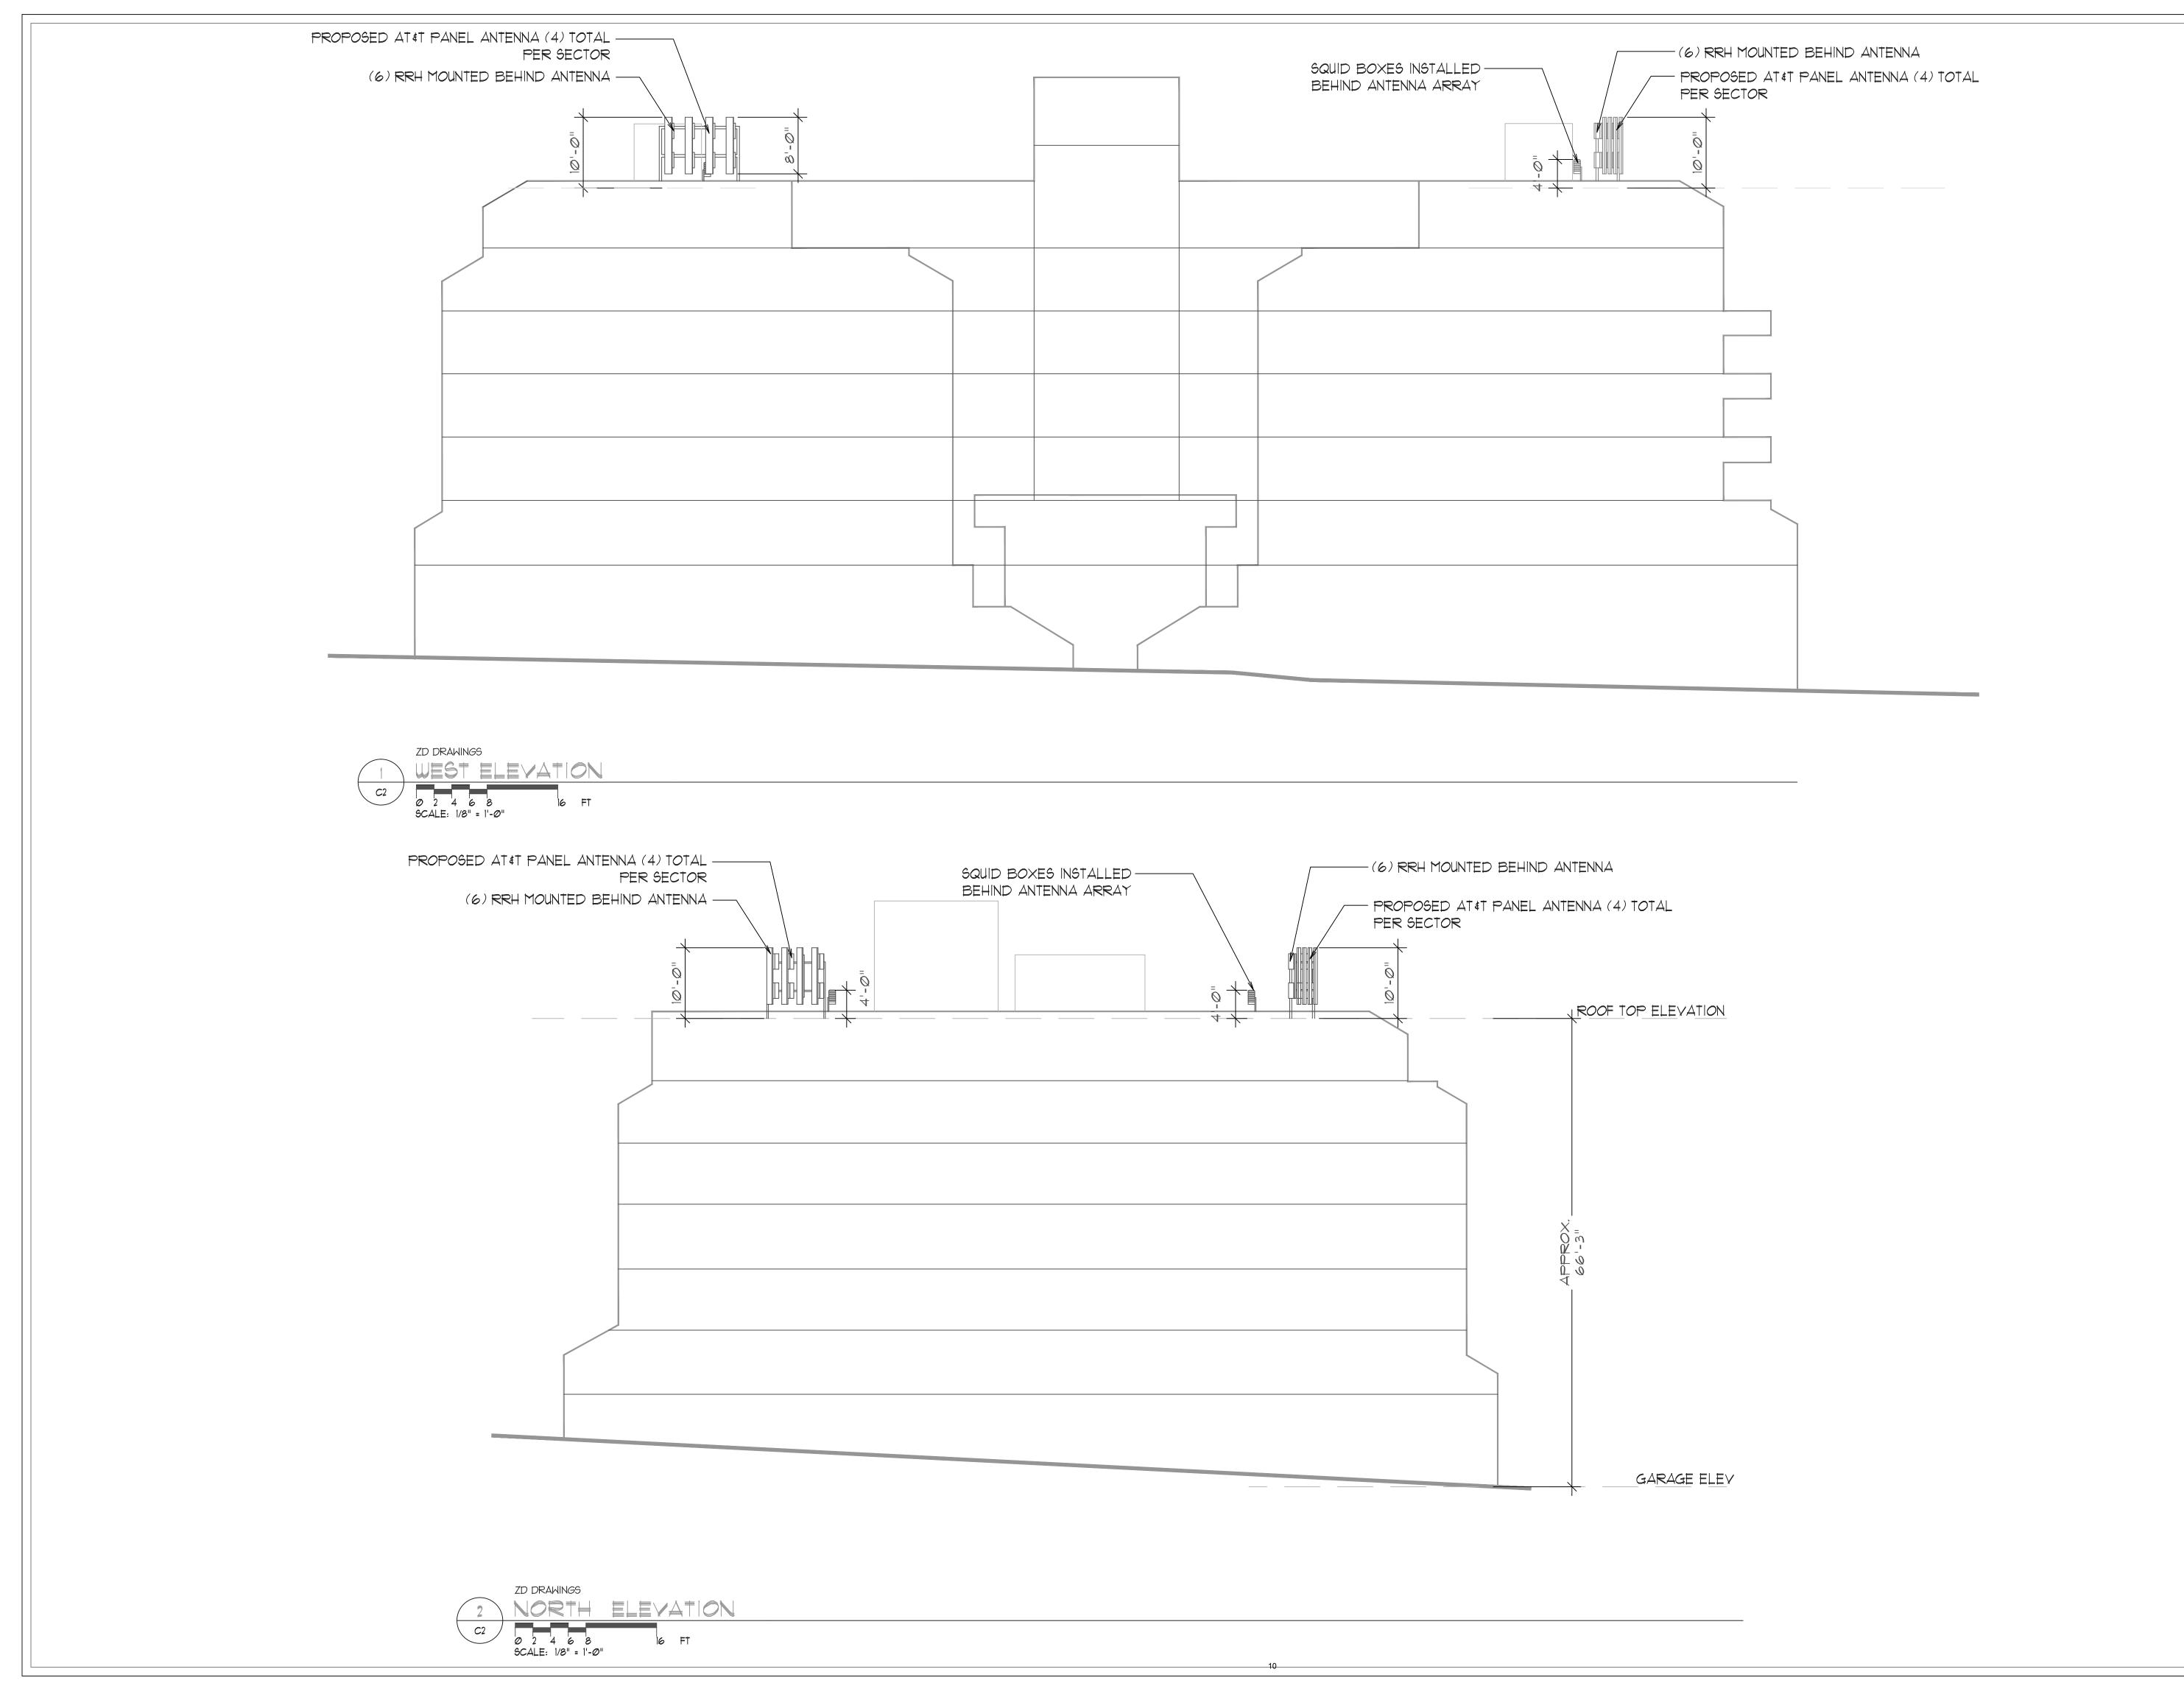



PROJECT INFORMATION

VIRGINIA SITE ID: SLKCUTUIØ5Ø FA# 1Ø547729

CURRENT ISSUE DATE

03/18/2014

- ISSUED FOR -

ZONING DRAWINGS

	- REV	— DATE —	DESCRIPTION	- BY -
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- PLANS PREPARED BY




CONSULTANT -

### **NSA WIRELESS, INC**

2010 CROW CANYON PLACE SUITE 335 SAN RAMON, CA 94583

DRAWN BY — CHK — APV — APV — APV —

LICENSER -

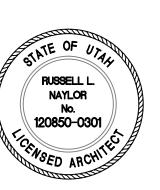

THESE ARE ZONING DRAWINGS AND ARE NOT TO BE USED FOR CONSTRUCTION

SHEET TITLE -

**ELEVATION** 

--- SHEET NUMBER

# ATTACHMENT D: EXISTING CONDITIONS & ZONING REQUIREMENTS

#### **CURRENT ZONING REQUIREMENTS**

Regulation	Requirement	Proposal	Compliance
Height	The height of the antenna should be directly proportional to the distance the antenna is setback	Antennae are setback at least 10 feet from the parapet wall and the height will be approximately 10 feet	Yes
Setback	Antennae shall be mounted at least five feet behind any parapet wall	Antennae are setback at least 10 feet from the parapet wall	Yes
Area Limitation	Not exceed sixty square feet or 5% of the gross square footage of each exterior wall of a building	Each antenna will be approximately 58.3 square feet, and it will be approximately:  •0.9% of the south wall,  •0.9% of the north wall, and  •1.5% of the west wall	Yes

#### ADJACENT LAND USE

The land use and zoning surrounding the site is:

- East and South: low density residences, and RMF-30 and R-2 zoning districts
- West: utility station and a four story medical office, and RMF-30 and RMF-45 zoning districts
- **North:** low and medium density residences, and R-2 zoning district
- Northwest: the Salt Lake Regional Hospital, and UI zoning district

### ATTACHMENT E: ANALYSIS OF STANDARDS

#### 21A.54.080 Standards for Conditional Use

**Approval Standards**: A conditional use shall be approved unless the planning commission, or in the case of administrative conditional uses, the planning director or designee, concludes that the following standards cannot be met:

1. The use complies with applicable provisions of this title;

**Analysis:** The property is located in the RMF-45, Moderate/High Density Multifamily Residential zoning district. As per Section 21A.40.090(E) of the Zoning Ordinance all rooftop mounted antennae in the RMF-45 zone require conditional use approval.

The subject building is approximately 66 feet high and it exceeds 21 feet from the maximum building height on the RMF-45 zoning district. Zoning Ordinance Section 21A.40.090.E.8 **allows** roof antennae on buildings that exceed the maximum allowable height of the zoning district to extend above the maximum height limit of the zoning district, if said antenna is allowed on the zoning district.

The subject property is located in a historic district and if the conditional use is approved, a Certificate of Appropriateness for historic appropriateness is required. The antennae will be located on the roof of the existing building at least 10 feet from the edge of the parapet. This setback is intended to reduce the visibility of the antennae. Furthermore, all conduit and fiber cables are proposed to run down through an existing stairwell and will connect to the equipment cabinets proposed to be installed in an existing storage room in the parking garage. These measures will either reduce or eliminate visual impact.

**Finding:** The proposal complies with the applicable provisions of the Salt Lake City Zoning Ordinance, provided that the request meets the conditions recommended as part of this staff report.

2. The use is compatible, or with conditions of approval can be made compatible, with surrounding uses;

**Analysis:** Surrounding the property are low density residences along with a utility station, a four story medical office across the street, and a hospital to the northwest of the site..

As stated earlier on this report, some neighbors are concerned that the proposed antennae will be located across the street from an electrical substation and that the addition of the antennae will detract from the residential integrity of the neighborhood. The antennae will be set back from the edge of the roof to reduce the visual impact. In addition, the nature of the land uses and the development pattern in the vicinity of 100 South and 1100 East includes a variety of building types and land uses at various scales, ranging from single story, single family homes to multi-story institutional uses.

**Finding:** Staff finds that wireless antennae are common in residential neighborhoods where they are needed to provide services to residents of the area and the proposal is generally compatible with the nature of the area.

3. The use is consistent with applicable adopted city planning policies, documents, and master plans; and

**Analysis:** The Central Community Master Plan is silent on matters related to wireless telecommunication equipment. The apartment building where the antennae are being proposed is a land use that is consistent with the Central Community Master Plan.

**Finding:** The project does not conflict the Central Community Master Plan.

4. The anticipated detrimental effects of a proposed use can be mitigated by the imposition of reasonable conditions (refer to Detrimental Impacts Chart below for details).

### 21a.54.080B Detrimental Effects Determination

In analyzing the anticipated detrimental effects of a proposed use, the planning commission shall determine compliance with each of the following:

Criteria	Finding	Rationale
1. This title specifically authorizes the use where it	Complies	The cellular tower is a conditional use in the RMF-
is located	-	45 zone and if approved according to the Zoning
		Ordinance process and standards, will not create a
		detrimental effect.
The use is consistent with applicable policies	Complies	The use is located in an area zoned and designed
set forth in adopted citywide, community, and		by the associated master plan as medium high
small area master plans and future land use maps		density residential (see analysis from standard 3
		above).
3. The use is well-suited to the character of the	Complies	Surrounding the property are low density
site, and adjacent uses as shown by an analysis		residences, a utility station, a four story medical
of the intensity, size, and scale of the use		office across the street, and a hospital on the kitty
compared to existing uses in the surrounding area		corner. The principal structure is an apartment
		building that will not change the use with this proposal. The antennae are sited and arranged on
		the subject building to reduce t heir visual impact
		and will not have a measurable impact the intensity,
		size or scale of the existing building.
4. The mass, scale, style, design, and	Complies	The antennae will have a minimum impact on the
architectural detailing of the surrounding		surrounding structures. The antennae are setback
structures as they relate to the proposed have		from the edge of the structure to reduce their visual
been considered		impact.
5. Access points and driveways are designed to	Complies	The proposal will have no traffic impact.
minimize grading of natural topography, direct		
vehicular traffic onto major streets, and not		
impede traffic flows		
6. The internal circulation system is designed to	Complies	The proposal will have no traffic impact.
mitigate adverse impacts on adjacent property		
from motorized, non-motorized, and pedestrian traffic		
7. The site is designed to enable access and	Complies	The proposal will have no traffic impact.
circulation for pedestrian and bicycles	Compiles	The proposal will have no traine impact.
8. Access to the site does not unreasonably	Complies	The proposal will have no traffic impact.
impact the service level of any abutting or	•	
adjacent street		
9. The location and design of off-street parking	Complies	The proposal will not require additional off-street
complies with applicable standards of this code		parking.
10. Utility capacity is sufficient to support the use	Complies	The proposal will not require additional utility
at normal service levels		service.
11. The use is appropriately screened, buffered,	Complies	The proposal will not change the land use.
or separated from adjoining dissimilar uses to		
mitigate potential use conflicts	Complies	Lies does not cignificantly imposed a vetal and title
12. The use meets City sustainability plans, does	Complies	Use does not significantly impact sustainability plans nor does it encroach onto a stream or water
not significantly impact the quality of surrounding air and water, encroach into a river or stream, or		·
introduce any hazard or environmental damage to		way.
any adjacent property, including cigarette smoke		
13. The hours of operation and delivery of the use	Complies	The proposal will not have operating hours.
are compatible with surrounding uses		
14. Signs and lighting are compatible with, and do	Complies	The proposal will not require signs and lighting.
not negatively impact surrounding uses		
15. The proposed use does not undermine	Complies	The site is in the University Historic District. The
preservation of historic resources and structures		building is noncontributing to the district. The
		antennae will be setback at least 10 feet from the
		parapet wall. Overhead utilities, mature vegetation
		and other buildings will obscure some of the view.
		The proposed conduit, fiber cables, and equipment
		cabinets will not be visible from the street.

**Finding:** In analyzing the anticipated detrimental effects of the proposed use, Staff finds that the request complies with the criteria listed above.

Section 21A.40.090.E.9 Additional Conditional Use Requirements (for antennae)

In addition to conditional use standards outlined in Section 21A.54 (above) of the zoning ordinance; the following shall be considered by the Planning Commission:

- a. Compatibility of the proposed structure with the height and mass of existing buildings and utility structures:
- b. Whether collocation of the antenna on the other existing structures in the same vicinity such as other towers, buildings, water towers, utility poles, etc., is possible without significantly impacting antenna transmission or reception;
- c. The location of the antenna in relation to existing vegetation, topography and buildings to obtain the best visual screening;
- d. Whether the spacing between monopoles and lattice towers creates detrimental impacts to adjoining properties.

**Analysis:** The adjoining land use is semi-urban and generally residential in nature, with overhead utilities and mature vegetation that obscure the view to and from the proposed rooftop. Taller buildings in the immediate vicinity of the proposed facility further lessen visual impacts. The proposed conduit and fiber cables are proposed to run down through an existing stairwell and will connect to the equipment cabinets proposed to be installed in a storage room in the parking garage. These measures will either reduce or eliminate visual impact.

**Finding:** This project satisfies the additional requirements of Section 21A.40.090.E.7.

### ATTACHMENT F: PUBLIC PROCESS AND COMMENTS

#### **PUBLIC PROCESS AND INPUT**

#### **Timeline**

- The application was submitted on March 27, 2014, and an update was received on September 30, 2014
- An open house was held on April 17, 2014
- A second open house (with an updated request) was held on October 16, 2014
- Mailings were sent out on October 30, 2014 for the planning commission meeting
- Sign was posted at 115 South 1100 East on November 2, 2014 for the planning commission meeting

#### The following is a list of the public comments received for this project:

- One call, on November 4, 2014, by one of the HOA Board members (Devon) in support of the project;
- Two written comment sheets in support of the project; and
- One email in opposition of the project.

# OPEN HOUSE PUBLIC COMMENT FORM

October 16, 2014



Planning and Zoning Division Department of Community and Economic Development

AT&T Roof Top Antennas 115 South 1100 East (Arlington Place Apartments)

Name:	Ulrui. A Morefor
Address:	115 S.1100 = #802
	<del></del>
	Zip Code
Phone:	-891-3418 E-mail
Comments:	This is actually a Community
Servie	e that kenigts many people
other	than the Home Owners of Arlington Place
	- Arlington Place does get a
Smal	I payment which can help with
build	ing maintenance keep dues for
thos	e on fixed incomes from sky rocketing
to Kee	pthe building a viable Community
0550	£ .

Please provide your contact information so we can notify you of other meetings or hearings on this issue. You may submit this sheet before the end of the Open House, or you can provide your comments via e-mail at <a href="mailto:katia.pace@slcgov.com">katia.pace@slcgov.com</a> or via mail at the following address: Katia Pace, Salt Lake City Planning Division, PO Box 145480, Salt Lake City, UT 84114-5480. <a href="mailto:Please">Please</a> provide your comments by Date October 24, 2014.

# AT&T STEALTH ANTENNAS ON ROOFTOP 115 South 1100 East (Arlington Place Apartments)

PLNPCM2014-00178 OPEN HOUSE COMMENT SHEET April 17, 2014

Please provide us with the following information:

Name Jonathan Yip
Email jonathan yip 18 yahoo, oom
Written comments:
I would like to show my support on this project.

#### Pace, Katia

From:

marie taylor [rosaritobeach@hotmail.com]

Sent:

Tuesday, May 13, 2014 10:48 AM

To:

Pace, Katia

Cc:

Julie Mack; joypat2000@xmission.com; wiehe74@msn.com; Garrott, Luke; esther hunter

Subject:

PLNPCM 2014-00178

### Good Morning Katia,

Regarding the ATT cell tower. We own 2 of the 3 residential properties adjacently, across the street from Arlington Place Condominiums (not Apartments). These are Condominiums, with by laws that limit how many can be rented. And it seems obvious that they are wanting to supplement their HOA due my having this tower on top of their building.

We are against this. (1) They have already asked for two Administrative Interpretations. We were pleased to see that these were both denied. It is not a use that is allowed in that zoning. (2) Directly across the street from them is an electrical substation, which is designated for infrastructure for the city. Infrastructure should be put in these designated areas, and not polka dotted all over the residential neighborhoods.

Our community council went through much effort to have the substation be as unsightly as possible. In order for our neighborhood to not look like an industrial area. Cell towers hanging off of buildings detracts from our residential neighborhood's integrity and will attract more such things, and ultimately bring down our property value.

We were surprised to see that this went to a hearing officer and not to the planning commission. And are somewhat disappointed with this choice.

Hasta Luego, Marie Taylor

"What would you dare to accomplish if you knew the only possible outcome was success?"
www.SheJumps.org

### ATTACHMENT G: DEPARTMENT REVIEW COMMENTS

The proposed conditional use was sent to the departments listed below for review and comment.

**SUSTAINABILITY REVIEW** – No comments received.

**PUBLIC UTILITIES** - No comments received.

**ZONING REVIEW** - Proposed roof top antennae exceed the maximum height limit for the zone. Proposed antennae are located in a historic district and require approval from the historic landmarks commission. Plans need to show dimensions and enough detail to show compliance with the follow provisions as per 21a.40.090.E.2.b(2). For antennae not mounted on a penthouse or mechanical equipment room, the antennae shall be mounted at least five feet (5') from the exterior wall of a building. For antennae mounted between five (5) and ten feet (10') from the exterior wall, the maximum height of a roof mounted antenna is directly proportional to the distance the antenna is set back from the exterior wall up to a maximum height of ten feet (10') above the roofline of the building to which the antenna is attached. Antennae shall be mounted at least five feet (5') behind any parapet wall. For antennae mounted between five (5) and ten feet (10') behind a parapet wall, the maximum height of the antenna is directly proportional to the distance the antenna is set back from the wall up to a maximum of ten feet (10') as measured from the top of the parapet wall. The antennae shall not extend more than fifteen feet (15') above the roofline of the building itself unless approved as a conditional use (see subsection 21A.62.050H of this title).

**ENGINEERING REVIEW** - No objection to the proposal.

**TRANSPORTATION REVIEW** - Verify ADA access corridor for van stall to maintain the required 8'-2" height clearance for the proposed ceiling mounted conduits.

FIRE CODE REVIEW - No comments received.

**POLICE REVIEW** – No comments received.

### ATTACHMENT H: MOTIONS

#### **Potential Motions**

Based on the findings listed in the staff report, it is the Planning Staff's opinion that the project adequately meets the applicable standards for a conditional use and therefore recommends the Planning Commission approve the application as proposed.

**Consistent with Staff Recommendation**: The motion recommended by the Planning Division is located on the cover page of this staff report. The recommendation is based on the above analysis.

**Not Consistent with Staff Recommendation:** Based on the information in this staff report, public testimony, and discussion by the Planning Commission, I move that the Planning Commission deny application PLNPCM2014-00178, for AT&T Rooftop Antennae at 115 South 1100 East.

The Planning Commission shall make findings on the following conditional use standards and specifically state which standard or standards are being complied with.

- 1. The use complies with applicable provisions of this title;
- 2. The use is compatible, or with conditions of approval can be made compatible, with surrounding uses;
- 3. The use is consistent with applicable adopted city planning policies, documents, and master plans; and
- 4. The anticipated detrimental effects of a proposed use can be mitigated by the imposition of reasonable conditions (refer to Detrimental Impacts Chart for details).

And the following additional conditional use requirement for antennae:

- a. Compatibility of the proposed structure with the height and mass of existing buildings and utility structures;
- b. Whether collocation of the antenna on the other existing structures in the same vicinity such as other towers, buildings, water towers, utility poles, etc., is possible without significantly impacting antenna transmission or reception;
- c. The location of the antenna in relation to existing vegetation, topography and buildings to obtain the best visual screening:
- d. Whether the spacing between monopoles and lattice towers creates detrimental impacts to adjoining properties.